
# BILTMORE GARDENS 24TH ST

### LOCATION MAP



### VICINITY MAP

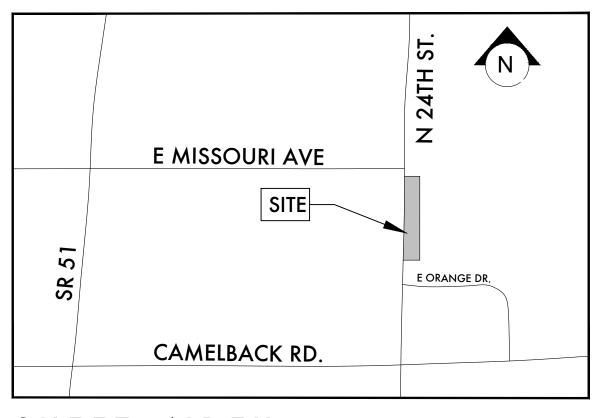

### SHEET INDEX

SHEET #	DESCRIPTION
LA-100	LANDSCAPE COVER SHEET
LA-101	SITE PLAN/INVENTORY + SALVAGE COM
LA-102	IRRIGATION PLAN + DETAILS
LA-201	LANDSCAPE + IRRIGATION DETAILS

### INVENTORY/SALVAGE PLAN APPROVAL

INVENTORY/SALVAGI	E PLAN APPROV	AL, CITY OF PHO	DENIX	DATE	
TOTALS & PERCENTAGES	TOTALS & PERCENTAGES	TOTALS & PERCENTAGES	NTAGES 0.3400 ACRES OF AREA		
REMAIN / PROTECT IN PLACE	6	0		USABLE MATERIAL	
SALVAGE	0	0	7	TOTAL NUMBER OF PLANTS	
DESTROY	1	0	,	INVENTORIED ON SITE	

### APPROVAL SIGNATURE BLOCK

LANDSCAPE ARCHITECT / CITY OF PHOENIX	DATE
ESTIMATED RIGHT-OF-WAY COST: 313,383.17	TOTAL ACRES OF LANDSCAPED AREA: 13,675
MAINTENANCE BY: CITY OWNER	PRELIMINARY SITE PLAN APPROVAL: 0.31
SQUARE FOOTAGE TURF: 0	ESTIMATED S.F. RIGHT-OF-WAY:

#### OWNER

### COLONY BILTMORE GREENS HOMEOWNERS

5725 N SCOTTSDALE RD STE C100 SCOTTSDALE PROPERTY. REMOVING DECLINING AZ, 85250 MICHAEL KESSELMAN CHRIS.PERRY@MACERICH.COM 240.855.4094

### LANDSCAPE ARCHITECT:

THE DESIGN LABORATORY 1050 E SOUTHERN AVE, UNIT 8 TEMPE, AZ 85282 JUSTIN AZEVEDO JUSTIN@THEDESIGNLABAZ.COM

530.961.3834

#### PROJECT NARRATIVE:

NEW 6'H CMU BLOCK WALL INSTALLATION ALONG THE OUTSIDE OF WEST SIDE OF OLEANDER. ADDING NEW FICUS HEDGE ALONG WALL & CHINESE PISTACHE TREES.

### ZONING

P A D - 8

ZONING CASE NUMBERS AND STIPULATIONS: N/A

### CITY OF PHOENIX GENERAL LANDSCAPE NOTES

- The City of Phoenix General Notes are the only notes approved on this plan. Additional general notes generated by the sealant and placed on the plans are not approved as part of this plan and are noted as such on
- 2. The design on these plans is only approved by the City in scope and not in detail.
- Construction quantities on these plans are not verified by the City. Approval of these plans are for permit purposes only and shall not prevent the City from requiring correction of errors in the plans where such errors are subsequently found to be in violation of any law, ordinance, health, safety, or other design issues.
- 3. Construction within the right-of-way shall conform to the latest applicable Maricopa Association
- of Governments (MAG) Uniform Standard Specifications and Details and the latest City of
- Phoenix Supplement to the MAG Uniform Standard Specifications and Details. 4. Final building permit cannot be obtained until bonding or approved assurances are provided for the
- landscaping within the right-of-way. No plant substitutions, type, size, or quantity, or deviations from the approved landscape or irrigation plans, are
- allowed without prior approval from the City of Phoenix Landscape Section at 602-262-7811 All plant material and specifications shall conform to the Arizona Nurseryman Association standards.
- All Right-Of-Way and City required (perimeter, retention, and parking) plant material shall be in compliance with the Department of Water Resources low water use plant list.
- Contact the Parks & Recreation Department, Forestry Supervisor, at 602-262-6862, to verify ownership of any plant material in the public R.O.W. prior to any plant re-locations or removals. Obtain written permission from the Parks and Recreation Department prior to the re-location or removal of any City plant material or equipment.
- 9. Contact the Street Transportation Department, Horticulturist, at 602-262-6284, prior to the re-location or removal of existing plant material in the A.D.O.T. R.O.W. that is on the City's side of the sound wall. Obtain written permission from the Street Transportation Department prior to the re-location or removal of any plant material or equipment.
- 10. All existing trees and shrubs in right-of-way designated to remain but are damaged or destroyed will be replaced in like size and kind by the contractor.
- 11. The proposed irrigation system shall include any modifications required to tie the existing City of Phoenix irrigation system in Right-Of-Way to the proposed system. All through irrigation systems in the Right-Of-Way shall be maintained. The contractor shall be responsible for capping and/or abandoning existing irrigation to plant materials and providing new irrigation to the existing plant material, in Right-Of-Way, per the approved plan.
- 15. Walls are not approved as part of the landscape plan but are shown for reference only.
- 16. Trees adjacent to pedestrian walkways should have a minimum canopy clearance of six feet eight inches (6'8") per Section 507 Tab A.II.A.3.1.10 of the City of Phoenix Zoning Ordinance.
- 17. PVC pipe laterals are required. A maximum of five feet (5') of poly tubing off of the P.V.C. pipe lateral is allowed. No poly tubing laterals are allowed.
- 18. Plant quantities and caliper sizes, per the specific zoning requirements for this site, provided in the legend on the approved plans are required to be installed in the field. Any deviations from the plan will require a revision to the
- Note Minimum caliper size is a zoning requirement. If the minimum caliper cannot be met at box size that is specified, then the box size must be increased to meet caliper requirements.
- 19. Plan approval is valid for 180 days. Prior to plan approval expiration, all associated permits shall be purchased or the plans shall be resubmitted for extension of plan approval. The expiration, extension, and reinstatement of Landscape plans and permits shall follow the same guidelines as those indicated in the Phoenix Building Construction Code Administrative Provisions Section 105.3 for Building permits.

### CITY OF PHOENIX GENERAL INVENTORY / SALVAGE NOTES

- The City of Phoenix General Notes are the only notes approved on this plan. Additional general notes generated by the sealant and placed on the plans are not approved as part of this plan and are noted as such
- on the plans. Plant materials must be individually tagged in the field at the time the Inventory Plans are submitted.
- Tagged material must be clearly marked with waterproof ink and include the number which corresponds to the number shown on the plan. A field review will not occur until clearly marked tags are in place on each plant to be included in the inventory.
- Tags must be attached so that they will remain on the plant for the duration of the salvage and nursery storage period. Plant materials without numbered tags in the nursery will not be counted toward the total requirement for the project.
- 5. All salvageable material is to be clearly flagged with tape or plastic tags visible from all directions. Tags shall be numbered to correspond with the plant inventory plan and legend.
- Color code as follows:
- Red  $\square$  Salvage and relocate.
- White 
  Preserve and protect in place.
- Blue Destroy, not salvageable and cannot remain in place.
- Contact the Parks & Recreation Department, Forestry Supervisor, at 602-262-6862, to verify Ownership of any plant material in the public R.O.W. prior to any plant re-locations or removals. Obtain written permission from the Parks and Recreation Department prior to the re-location or removal of any City plant material or equipment.
- 6. Contact the Street Transportation Department. Horticulturist, at 602-262-6284, prior to the re-location or removal of existing plant material in the A.D.O.T. R.O.W. that is on the City's side of the sound wall. Obtain written permission from the Street Transportation Department prior to the re-location or removal of any plant material or equipment.
- 7. A Salvage permit shall be obtained and completed prior to the Grading and Drainage permit being issued. No clearing or grubbing may occur prior to the purchase of the Salvage Permit, field approval of the construction fence, and all salvaged plants placed in the nursery and field inspected.
- All protective fencing shall be in place before any earth moving equipment is moved onto the site and before any salvage, clearing or grubbing takes place. Call 602-262-7811 to schedule an inspection of


### construction fence.

- 9. All material to be salvaged shall be removed and placed in the designated nursery area before any clearing or grading takes place. Call 602-262-7811 to schedule an inspection after salvage is completed.
- 10. All tagged materials must remain in nursery or on-site until nursery check is approved.
- 11. No nails, wires or other objects that damage the cambium or cause injury to the tree may be used during the salvage process. All efforts shall be taken by using padding or other methods to preserve the integrity of the bark.
- 12. Trees and protected plant material or material noted for salvage that are destroyed or die during the salvage, relocation, or maintenance period will be replaced with a plant of equal or greater size and type by the responsible party a minimum of 90 days before the completion of the project. No Certificates of Occupancy will be issued before all required material has been replaced. All Replacement material shall be approved by the Planning & Development Landscape Architect. A maximum of 10% of the salvageable plant material will not be required to be replaced if lost.
- 13. All requirements of the State of Arizona, including the "Notice of Intent to Clear Land," shall be met notwithstanding any approvals by the City of Phoenix.
- 14. File Notice of Intent (NOI) to clear land with the State of Arizona, 602-542-6408.
- Provide a copy of the NOI Permit to the inspector. http://www.azda.gov/ESD/clearland.pdf
- 15. Provide a copy of the County Dust Control Permit to the inspector.
- 16. No salvage material shall be removed from the site without Planning & Development Landscape Architect approval.
- 17. Knowingly or negligently providing false or misleading information to the City of Phoenix regarding salvageable materials may result in delays and/or suspension of permits and inspections.
- 18. Plan approval is valid for 180 days. Prior to plan approval expiration, all associated permits shall be purchased or the plans shall be resubmitted for extension of plan approval. The expiration, extension, and reinstatement of Inventory/Salvage Combination plans and permits shall follow the same guidelines as those indicated in the Phoenix Building Construction Code Administrative Provisions Section 105.3 for Building permits.

KIVA# 00-6596 SDEV# SCSR # LSPL# 2302189 QS# 19-33 PRLM# AMND#





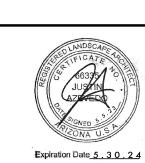

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**COLONY BILTMORE GARDENS HOA** 

ΙZ

DATE 05.05.2023

DRAWNBY J.A. & S.H.

PROJECT NO.


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SHEET NO. LANDSCAPE COVER SHEET LA100

1 OF 4

### **INVENTORY & SALVAGE SCHEDULE (SEE DETAILLA-101:1)**

			<del>`</del>		CURRENT			PLANT NURSERY
ID	COMMON NAME	BOTANICAL NAME	FULL GROWN HT. (FT)	FULL GROWN SP (FT)	CALIPER (INCH) OR HEIGHT	ACTION	NOTES:	NOT APPLICABLE. NO PLANTS BEING SALVAGED.
			, ,	, ,	(FT)			SALVAGE COST ESTIMATE
1.3	CAROB	CERATONIA SILIQUA	50	50	27"	RIP		TREE SALVAGE \$850/TREE X 0 TREES= \$0
1.4	RED GUM EUCALYPTUS	EUCALYPTUS CAMALDULENSIS	80	40	36"	RIP		TREE+CACTI TO REMAIN IN PLAC \$125/PLANT X 6 TREES = \$750
1.5	CAROB	CERATONIA SILIQUA	50	50	32"	RIP		TOTAL \$750
1.6	RED GUM EUCALYPTUS	EUCALYPTUS CAMALDULENSIS	80	40	50"	RIP		TREES SALVAGE AND REMAIN IN PLACE
2.5	QUEEN PALM	SYAGRUS ROMANZOFFIANUM	35	15	10"	RIP		\$300/CALIPER INCH x 171 CALIPER INCHES = \$51,300
2.6	QUEEN PALM	SYAGRUS ROMANZOFFIANUM	35	15	10"	RIP		ACTION LEGEND
3.3	MEXICAN FAN PALM	WASHINGTONIA ROBUSTA	80	10	16"	D	IN THE WAY OF NEW WALL & FOOTER OF NEW WALL	B DESTROY - BLUE TAG W REMAIN IN PLACE - WHITE R TAG SALVAGE - RED TAG

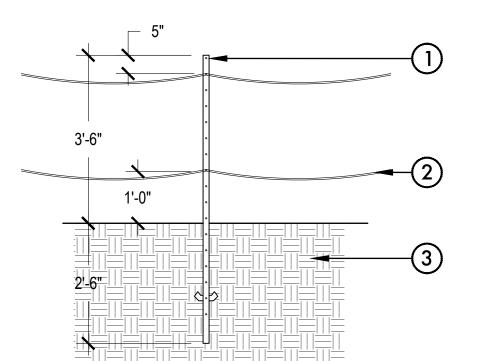

- T-BAR POST. SPACED 6' O.C. MAXIMUM
- (2) GOLD ROPE (TYP)
- 3 NATIVE SOIL

NOTE

FENCE TO BE LOCATED AS **CLOSE AS POSSIBLE TO TREE** CANOPY


SALVAGED (RELOCATED)	0
UNSALVAGEABLE (DESTROYED)	1
REMAIN IN PLACE	6

**GROUNDCOVER** RETAIN + MATCH + REGRADE EXISTING D.G.

NOTE: ALL TREES TO HAVE ROOT BARRIER PARALLEL TO SIDEWALK & UTILITY LINES SEE DETAIL (LA-201:10)

### CONSTRUCTION FENCE DETAIL

SCALE:  $\frac{1}{2}$ " = 1'-0"

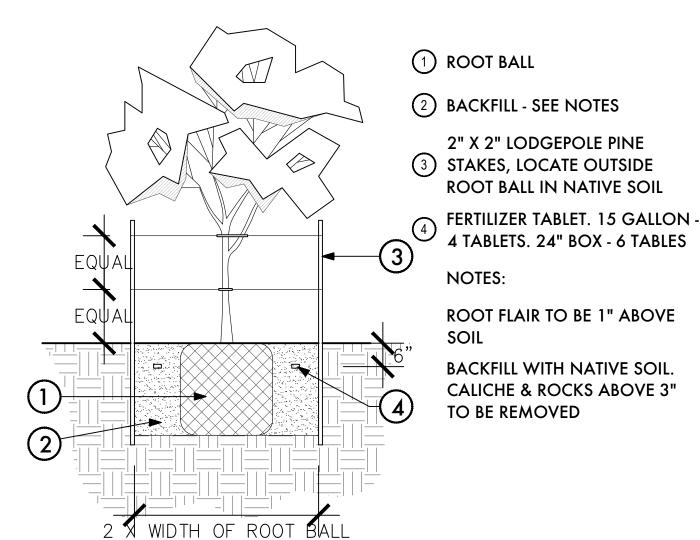


TREE PLANTING AND STAKING

KIVA# 00-6596 SDEV# SCSR # LSPL# 2302189 QS# 19-33 PRLM#

AMND#



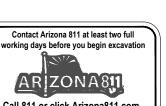

### DATE 05.18.2023

DRAWNBY

COLONY BILTMORE

**GARDENS HOA** 

J.A. & S.H.

.02822

PROJECT NO.

SHEET NO. SITE PLAN/

INVENTORY + SALVAGE COMBO

LA101

2 OF 4

## PLANTING GENERAL NOTES:

SHALL REVIEW TYPICAL TREE STAKING PRIOR TO FINAL ACCEPTANCE.

(NOT APPROVED AS A PART OF THIS PLAN)

- THE CONTRACTOR SHALL REVIEW PLANTING PLAN WITH LANDSCAPE ARCHITECT PRIOR TO INSTALLATION.
  THE LANDSCAPE ARCHITECT OR REPRESENTATIVE RESERVES THE RIGHT TO REFUSE ANY PLANT MATERIALS HE DEEMS UNACCEPTABLE. SEE SPECIFICATIONS.
  THE CONTRACTOR SHALL SUPPLY AND INSTALL ALL PLANT MATERIAL AS SPECIFIED ON THE PLANTING PLANS. HOWEVER, SHOULD THE PLANT MATERIAL BE TEMPORARILY UNAVAILABLE, THE CONTRACTOR SHALL NOTIFY THE LANDSCAPE ARCHITECT AND INSTALL 5 GALLON NURSERY BUCKETS WITH IRRIGATION AT EACH PLANT LOCATION. AS THE PLANT MATERIAL BECOMES AVAILABLE, THE 5 GALLON BUCKETS SHALL BE REMOVED AND PLANT MATERIAL INSTALLED AND ALL SUBSTITUTIONS TO BE APPROVED BY THE LANDSCAPE
- ARCHITECT.

  LOCATE PLANTS AWAY FROM SPRINKLER HEADS, LIGHT FIXTURES AND OTHER OBSTRUCTIONS.

  FINAL LOCATION OF ALL PLANT MATERIAL SHALL BE SUBJECT TO THE APPROVAL OF THE OWNER'S AUTHORIZED REPRESENTATIVE.

  PLANTING AND IRRIGATION DESIGN MAY BE MODIFIED TO ADAPT TO WALK CONFIGURATIONS THAT DIFFER FROM THESE PLANS, OR BECAUSE OF GRADE LIMITATIONS ON SITE.
- WATER TEST ALL TREE PLANTING HOLES PRIOR TO PLANTING. IF TREE HOLE DOES NOT DRAIN, DO NOT PLANT, SEE HARDPAN DETAIL. REFER TO THE SPECIFICATIONS FOR ADDITIONAL REQUIREMENTS NOT SHOWN ON DRAWINGS.
- TREES SHALL BE PLANTED A MINIMUM OF 10'-0" FROM STREET LIGHTS / FIRE HYDRANTS, 6'-0" FROM EDGE OF UNDERGROUND PIPELINES AND AMINIMUM OF 4'-0" FROM WALKS, CURBS AND WALLS. SHRUBS SHALL BE PLANTED A MINIMUM OF 2'-0" FROM CURB AND WALKS.

  ALL SPECIMEN TREES, SHRUBS AND CACTI SHALL BE FIELD LOCATED BY LANDSCAPE ARCHITECT OR OWNER'S
- AUTHORIZED REPRESENTATIVE. THE CONTRACTOR SHALL INSTALL ARBOR GUARDS AT ALL TREES LOCATED IN TURF AREAS.
- THE CONTRACTOR SHALL INSTALL ARBOR GUARDS AT ALL TREES LOCATED IN TURF AREAS.

  ON-SITE AND OFF-SITE TOPSOIL SHALL CONFORM TO CONTENT REQUIREMENTS AS SPECIFIED IN PART 2 OF THE PLANTING SPECIFICATIONS. AGRONOMY TEST SUBMITTALS ARE REQUIRED FOR ALL MATERIAL USED FOR TOPSOIL AND BACKFILL. SUBMIT REPORT TO LANDSCAPE ARCHITECT FOR REVIEW.

  ALL PLANT MATERIAL SHALL BE IN COMPLIANCE WITH THE AMERICAN STANDARDS FOR NURSERY STOCK, LATEST EDITION.

  THE CONTRACTOR SHALL PROVIDE MAINTENANCE FOR ALL PLANT MATERIAL FROM THE TIME OF INSTALLATION THROUGH SUBSTANTIAL COMPLETION.

  CACTI SHALL BE PLANTED A MINIMUM OF 3'-0" AWAY FROM ALL PEDESTRIAN ROUTES AND SHALL BE WELL ROOTED AND NON-SCARRED.

  NATIVE REVERDE DEMONS ALL DEAD DERDIES. INVASIVE WEEDS. REMOVE ALL DEAD DEBRIS. ALL TREE STAKING SHALL CONFORM TO THE PLANTING DETAILS OR AS NOTED IN THE SPECIFICATIONS. THE LANDSCAPE ARCHITECT OR OWNER'S AUTHORIZED REPRESENTATIVE



SHRUB AND GROUNDCOVER PLANTING

FERTILIZER TABLET. ONE GALLON CONTAINER - 1 TABLET. FIVE GALLON **CONTAINER - 2 TABLETS** ROOT FLAIR TO BE 1" ABOVE

**BACKFILL WITH NATIVE SOIL.** CALICHE & ROCKS ABOVE 3" TO BE REMOVED

1 ROOT BALL

2 BACKFILL - SEE NOTES

(3) SHRUB OR GROUNDCOVER

SCALE: NTS

**SCALE: NTS** 

S C A L E: 1"=20'-0"

SIZE BRANCH QT

5 GAL 22

**PLANT SCHEDULE** 


TREES (SEE DETAIL LA-101 : 2) 2" CALIPER 3 CHINESE PISTACHE PISTACIA CHINENSIS SHRUBS (SEE DETAIL LA-101:3) FICUS HEDGE FICUS NITIDA

COMMON NAME BOTANICAL NAME


MATERIAL SCHEDULE SYM. MATERIAL QTY. 6' H 8"x8"x16" CMU BLOCK WALL

THE DESIGN LABORA

S

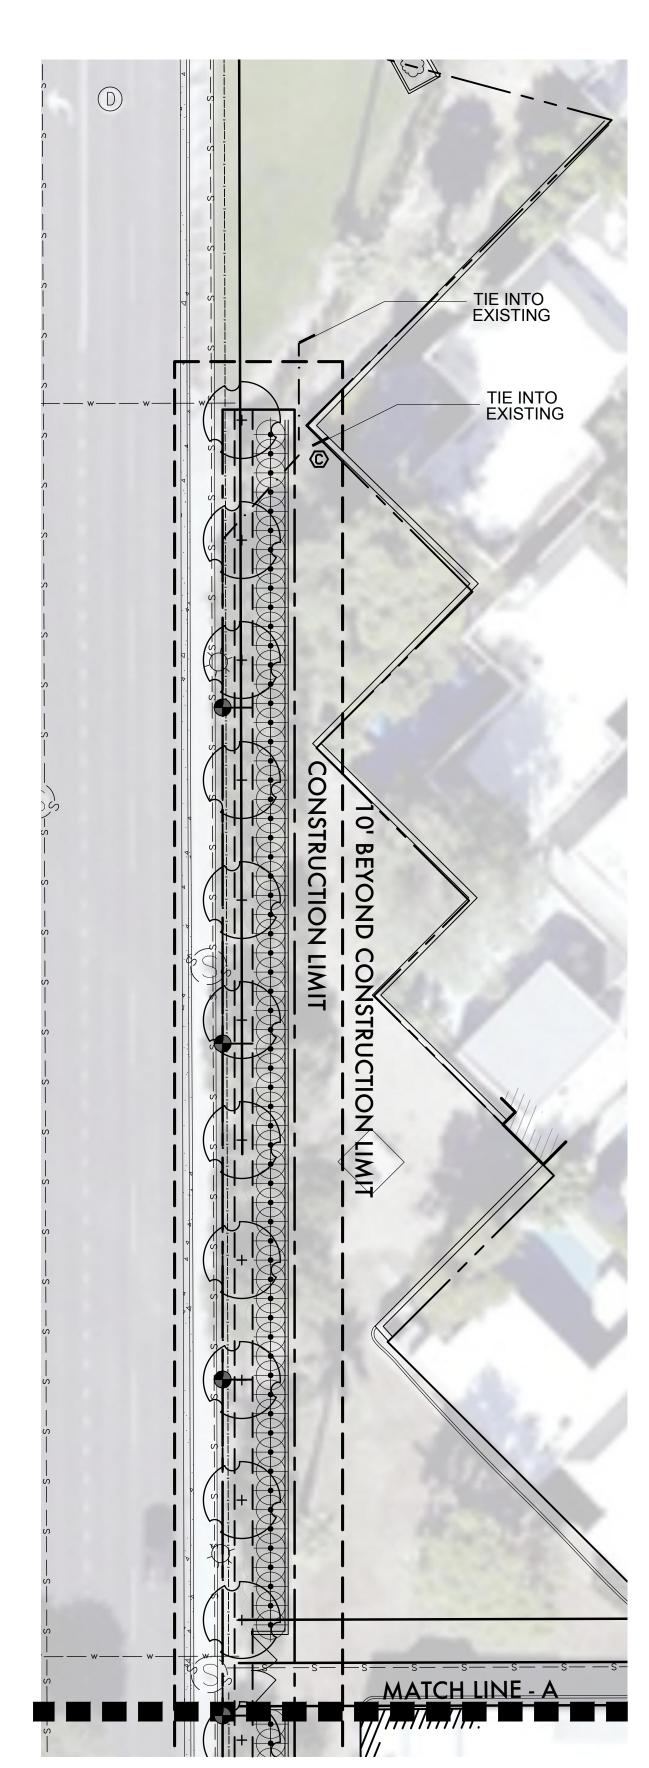

### IRRIGATION PLAN

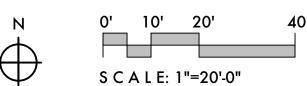



### GENERAL IRRIGATION NOTES:

(NOT APPROVED AS A PART OF THIS PLAN)

- REFER TO EMITTER DETAILS FOR EMITTER SPECIFICATIONS, LAYOU FTOR PROVIDING DISTRIBUTION TUBING, QUANTITIES, AND LOCATION TO EACH PLANT.
- ADJUST IRRIGATION OPERATING TIMES TO ACCOMMODATE PLANT MATURITY, SOIL TYPE, PLANT EXPOSURE AND SEASONAL REQUIREMENTS.
- IRRIGATION DESIGN IS SCHEMATIC FOR GRAPHIC CLARITY, ALL EQUIPMENT SHALL BE IN PLANTING AREAS.
- 4. CONTRACTOR IS TO NOTIFY LANDSCAPE ARCHITECT IF ANY SYSTEM ADJUSTMENTS ARE NECESSARY DUE TO UNKNOWN SITE CONDITIONS, PRESSURE DISCREPANCIES,
- 5. APPROXIMATE LOCATION OF MAINLINE AND VALVES ARE SHOWN ON PLAN. FINAL LOCATION IS TO BE DETERMINED BY OWNER'S REPRESENTATIVE. AVOID LOCATING VALVES AND VALVE BOXES IN PLAIN VIEW.
- 6. INSTALL IRRIGATION MATERIAL/ EQUIPMENT PER PLANS, DETAILS, NOTES AND MANUFACTURER'S SPECIFICATIONS. CONTRACTOR IS RESPONSIBLE FOR COSTS AND LIABILITY RELATED TO WORK WHICH IS NOT PER DOCUMENTATION.
- 7. VALVE SYSTEM: 7.1. VALVES ARE TO SERVE SIMILAR PLANT TYPOLOGIES RECOMMENDED ARE:
  - TREES
  - SHRUBS
  - CACTI - ANNUALS
- 8. TEMPORARY IRRIGATION IS TO BE INSTALLED FOR ALL EXISTING TREES UPON REMOVAL OF GRASS IRRIGATION AS WATER SOURCE THROUGH THE INSTALLATION OF THE NEW IRRIGATION.
- 9. MULTI HEAD PORT EMITTERS SHALL BE PLACED WITHIN A DRIP EMITTER SUBTERRANEAN BOX. RAINBIRD SEB7XB OR SIMILAR.
- 10. WATER ATTACHMENT LOCATIONS TO BE VERIFIED BY CONTRACTOR

### IRRIGATION SCHEDULE

TYPE	MODEL	EMITTER TYPE	BUBBLER TYPE	QUANTITY
EXISTING PALMS	HUNTER PCB-20		BUBBLERS	3
EXISTING TREES	HUNTER PCB-20		BUBBLERS	4 TO 6
CACTI	HUNTER PCB-20	1 GAL DRIP EMITTERS	BUBBLERS	1 PER PLANT
SHRUBS	HUNTER PCB-20	2 GAL DRIP EMITTERS	BUBBLERS	1 PER PLANT
TREES	HUNTER PCB-20	2 GAL DRIP EMITTERS	BUBBLERS	4 PER PLANT


### **EMITTER SCHEDULE**

ТҮРЕ	MODEL - BOWSMITH EMITTER	QUANTITY/PLAN T	TOTAL GPH
TREES			
15 GAL	ML-201	2	10
24" BOX	ML-201	2	10
SHRUB, ACCENT			
1 GAL	SL-210	1	1
5 GAL	SL-210	1	1

#### IRRIGATION FOLLIPMENT SCHEDLILE

IRRIGATION EQUIPMENT SCHEDULE				
SYMBOL	ТҮРЕ	DETAIL		
	BACKFLOW PREVENTER	CONNECT TO EXISTING		
•	VALVE : RAINBIRD PGA (DRIP)	LA-201 : 12		
	END CAP			
M	WATER METER			
	TREE & SHRUB LATERAL, PVC SCH. 40. SIZE PER PIPE SHEDULE	LA-201 : 8		
	MAIN LINE: PVC SCH. 40. SIZE PER PIPE SCHEDULE	LA-201 : 8		
	SLEEVE: PVC SCH. 40. 2X PIPE TO BE SLEEVED	LA-201 : 11		
	EMITTERS	LA-201 : 4, 5, 6, 7		
©	CONTROLLER (RACHIO 3 & WEATHER ENCLOSURE IRRIGATION CONTROL CLOCKS OR SIMILAR)	CONNECT TO EXISTING		

### VICINITY MAP

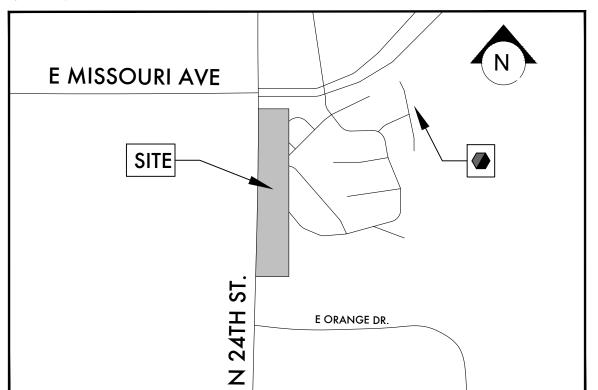

### IRRIGATION POINT OF CONNECTION NOTES:

(NOT APPROVED AS A PART OF THIS PLAN)

1. POINT OF CONNECTION: INSTALL ONE GATE VALVE, TRANSITION TO SCHEDULE 40 PYCAND EXTEND TO VALVES. THE CONTRACTOR SHALL CONFORM TO ALL LOCAL CODES. THE CONTRACTOR SHALL OBTAIN AND PROVIDE PAYMENT FOR ALL PERMITS ASSOCIATED WITH THIS WORK. FINAL LOCATION OF BACKFLOW PREVENTER SHALL BE APPROVED BYOTWIENERS REPRESENTATIVERIOR TO INSTALLATION.

CONTROLLER LOCATION CONTRACTOR TO COORDINATE W/ LANDSCAPE ARCHITECT & LANDSCAPE MAINTENANCE COMPANY REPRESENTATIVE.

WATER PRESSURETHE SYSTEM HAS BEEN DESIGNED FOR A REQUIRED MINIMUM STATIC PRESSURE Q10-50 PSI WHEN MEASURED AT THE UPSTREAM TEST COCK ON THE BACKFLOW PREVENTER. THE CONTRACTOR IS RESPONSIBLE FOR VERIFYING THE PRESSURE IN THE FIELD BEFORE CONSTRUCTION BEGINS AND FOR NOTIFYING TICEWNERS REPRESENTATIVOF ANY DISCREPANCY BETWEEN THE DESIGN PRESSURE OF THE IRRIGATION SYSTEM AND THE MEASURED PRESSURE IN THE FIELD.

### IRRIGATION LEGEND

VALVE	DESCRIPTION	NOTES
1	ACCENTS + CACTI	1 ½"
2	TREES	1 ½"

### PIPE SCHEDULE

PIPE SIZE	GALLONS/ MINUTE	PIPE SIZE	GALLONS/ MINUTE
<u>1</u> 111	0-5	1 ½"	16-25
<u>3</u> π 4	6-10	1 ½"	26-35
1"	11-15		

### **VALVE SCHEDULE**

EACH BUILDING TO HAVE MINIMUM				
1	SHRUB VALVE			
1	ACCENTS + CACTI VALVE			
2	TREES VALVE			

### **NOTES**

1	<ul> <li>ALL 1/2 " LATERAL PIPE TO BE CLASS 315 PVC. AL PIPE 3/4" TO 2-1/2" TO BE SCH. 40 PVC. PIPE 3" AND LARGER TO BE CLASS 200 PVC OR AS NOTED ON IRRIGATION LEGEND.</li> <li>MAINLINE - SCH. 80 FITTINGS</li> <li>LATERAL AND DRIP LINES SCH. 40 FITTINGS.</li> <li>PRESSURE TEST, 4 HOURS:</li> <li>MAINLINE 150 PSI</li> <li>LATERALS AND DRIP LINE 70 PSI</li> </ul>
2	SLEEVE PER DETAILS (SLEEVE UNDER ALL PAVING INCLUDING ALL FUTURE ANTICIPATED VEHICULAR ENTRANCES, SIDEWALKS, DRAINAGE STRUCTURES, AND ETCETERA TYPICAL).
3	LATERAL LINES - COORDINATE FINAL LOCATION WITH GENERAL CONTRACTOR AND OTHER TRADES PRIOR I BREAKING GROUND. (400' MAX. LENGTH FROM MAINLINE).
4	AUTOMATIC IRRIGATION VALVE WITH Y-STRAINER LOCATION TYPICAL. (INSTALL PER DETAILS IN NEAR VICINITY - COORDINATE PLACEMENT WITH SITE SUPERINTENDENT)
5	MULTIHEAD EMITTERS ARE TO BE USED WHEN AVAILABLE

KIVA# 00-6596 <u>S D E V #</u> SCSR # LSPL# 2302189 QS# 19-33 PRLM# AMND#





N 24TH ST PHOENIX,

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05.05.2023

DATE

DRAWNBY

J.A. & S.H.

.02822

PROJECT NO.

SHEET NO.

LA102

IRRIGATION PLAN


3 OF 4







Expiration Date 5 . 3 0 . 2 4

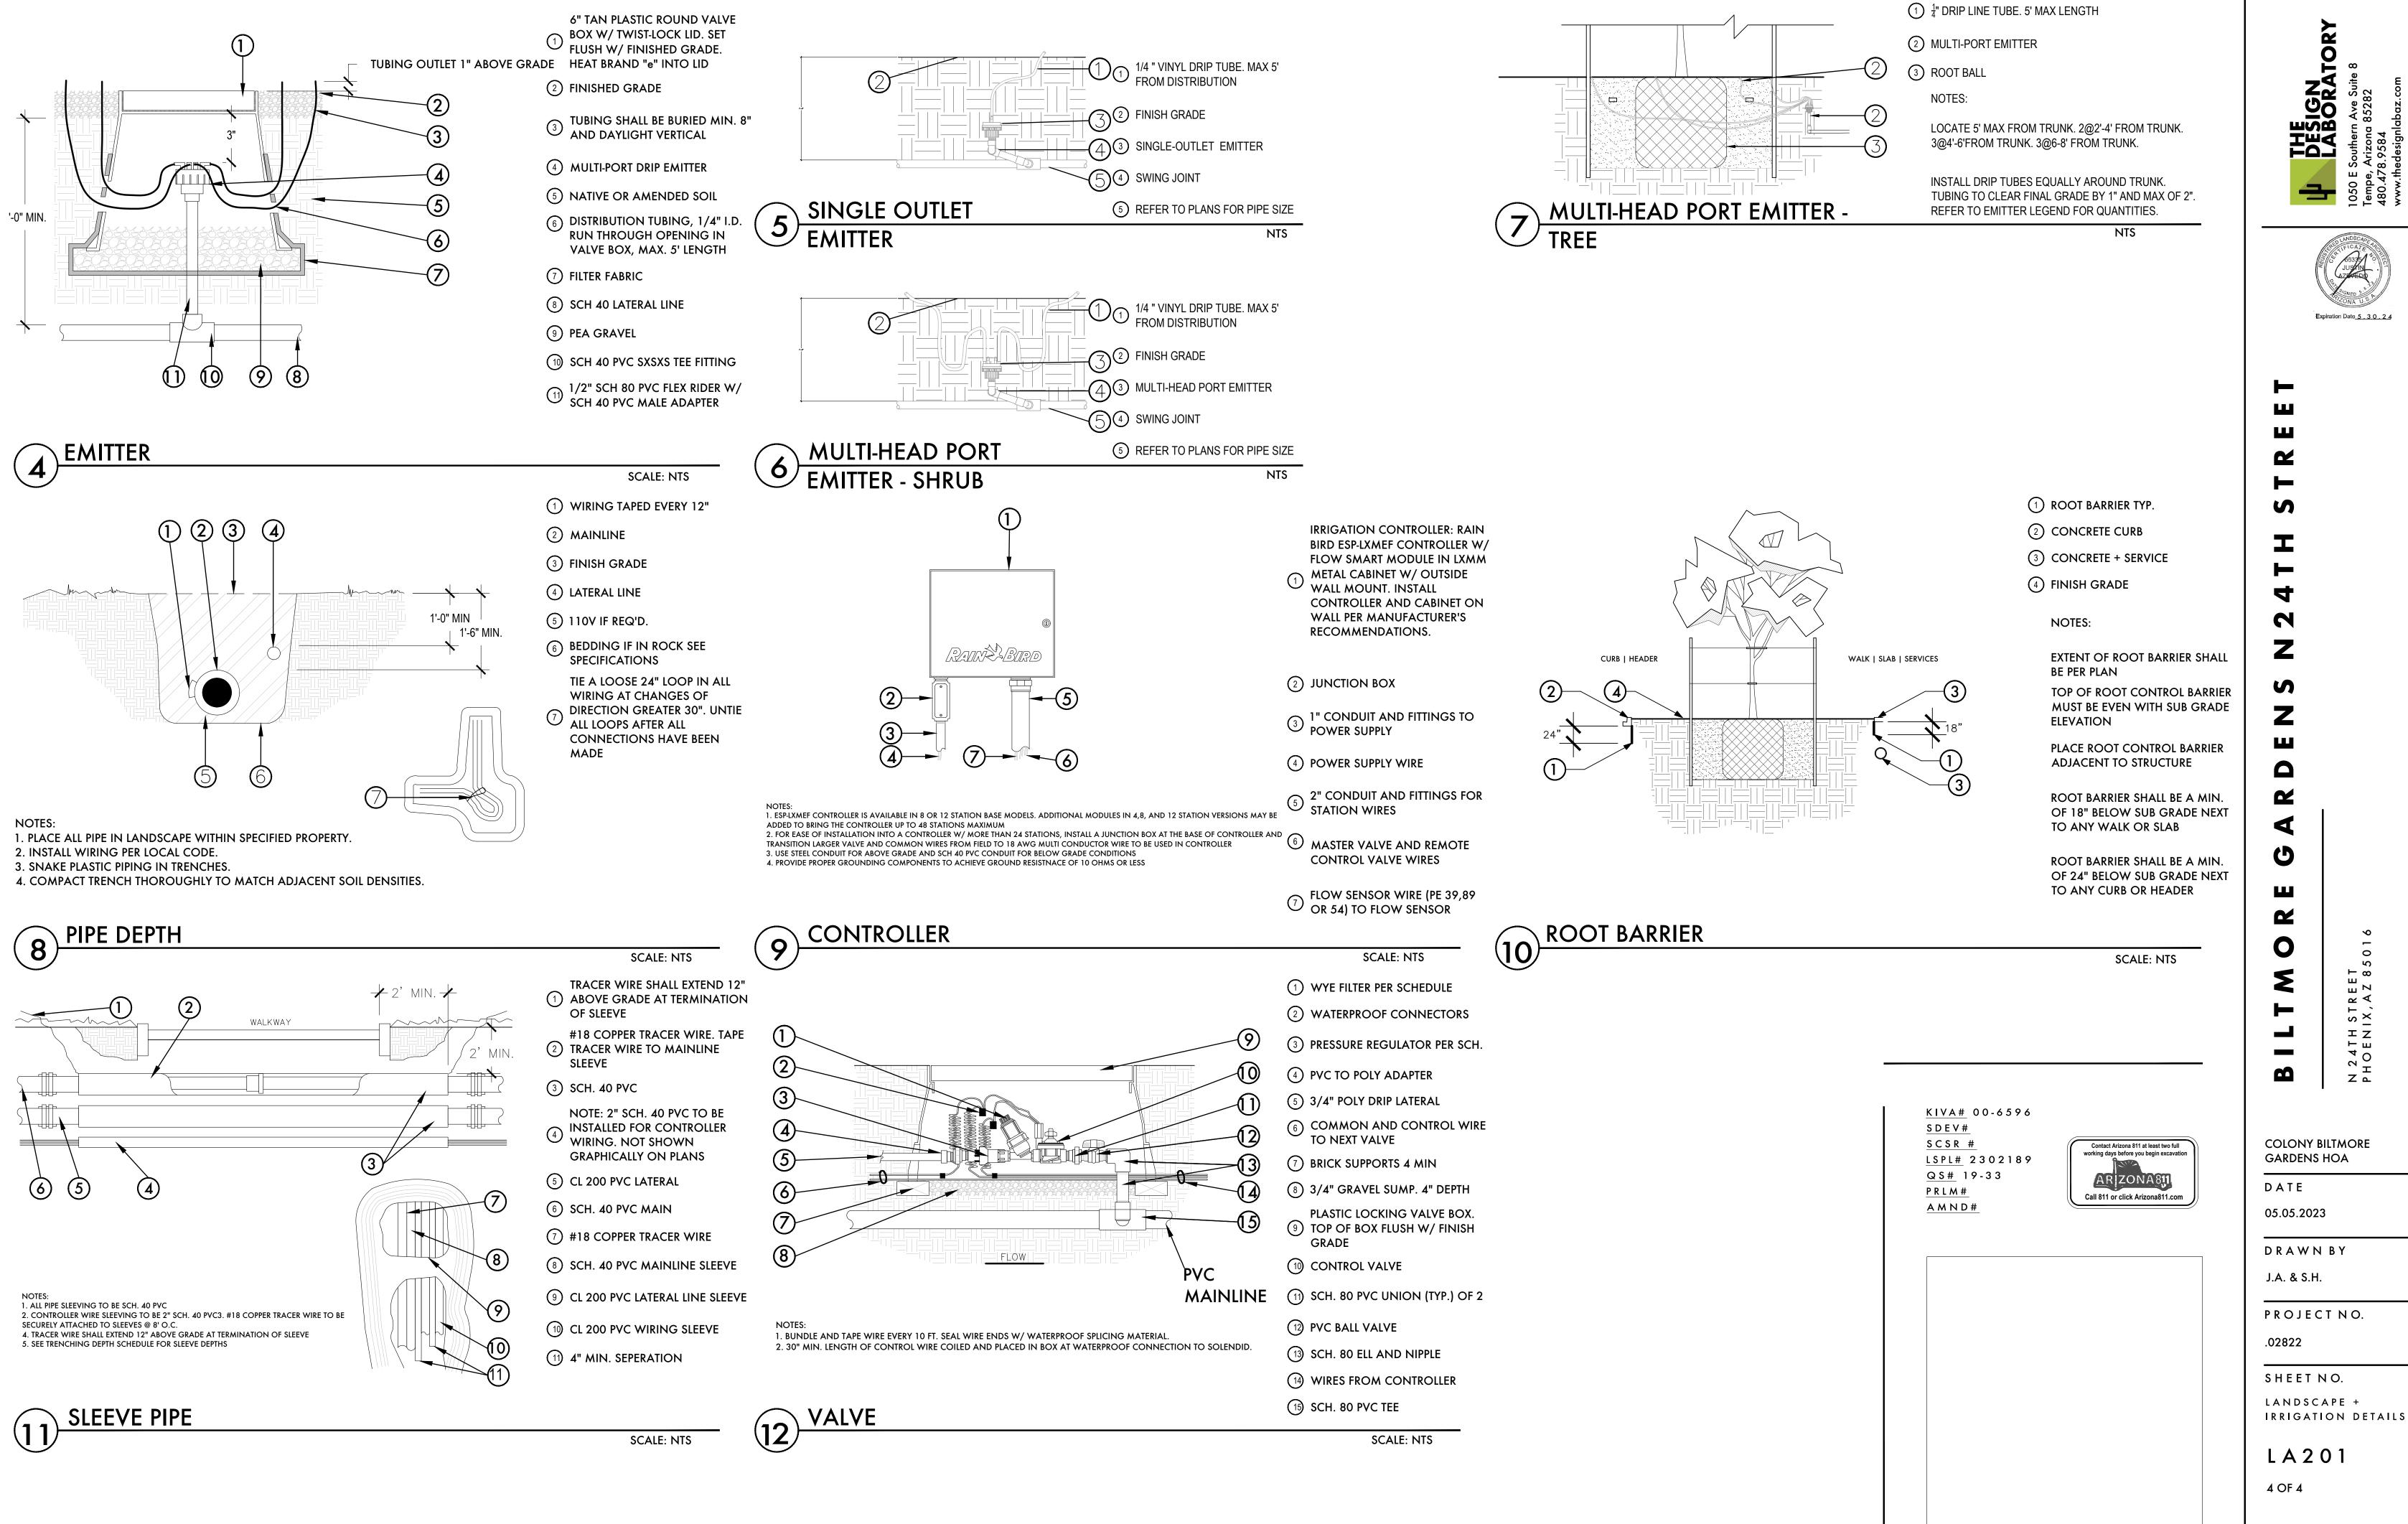

THE DESIGN LABORATORY

Expiration Date 5 . 3 0 . 2 4

2 

**COLONY BILTMORE GARDENS HOA** 

DATE

DRAWNBY

J.A. & S.H.

PROJECT NO.

SHEET NO. LANDSCAPE +

LA201

4 OF 4